



CITY OF OXNARD - CALIFORNIA


PLANS FOR

PILASTER JACKET REPAIRS, MANDALAY BAY SEAWALLS


SPECIFICATION NO. PW XX-XX

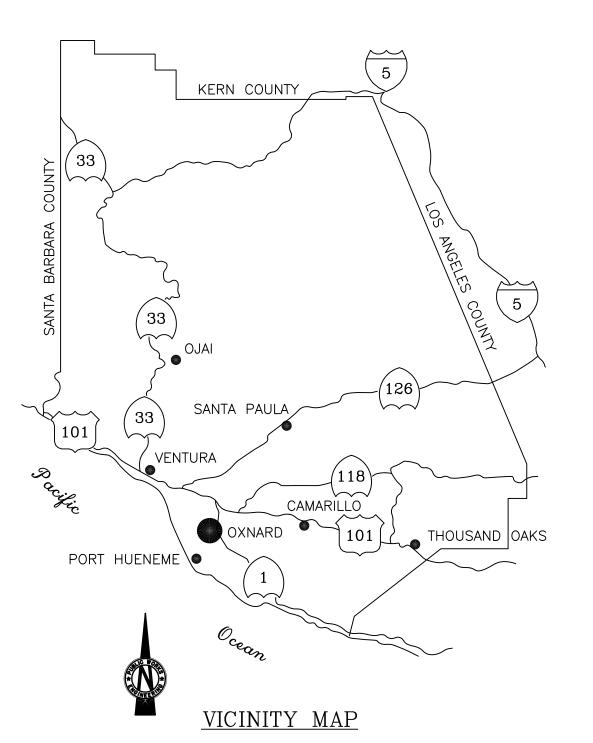

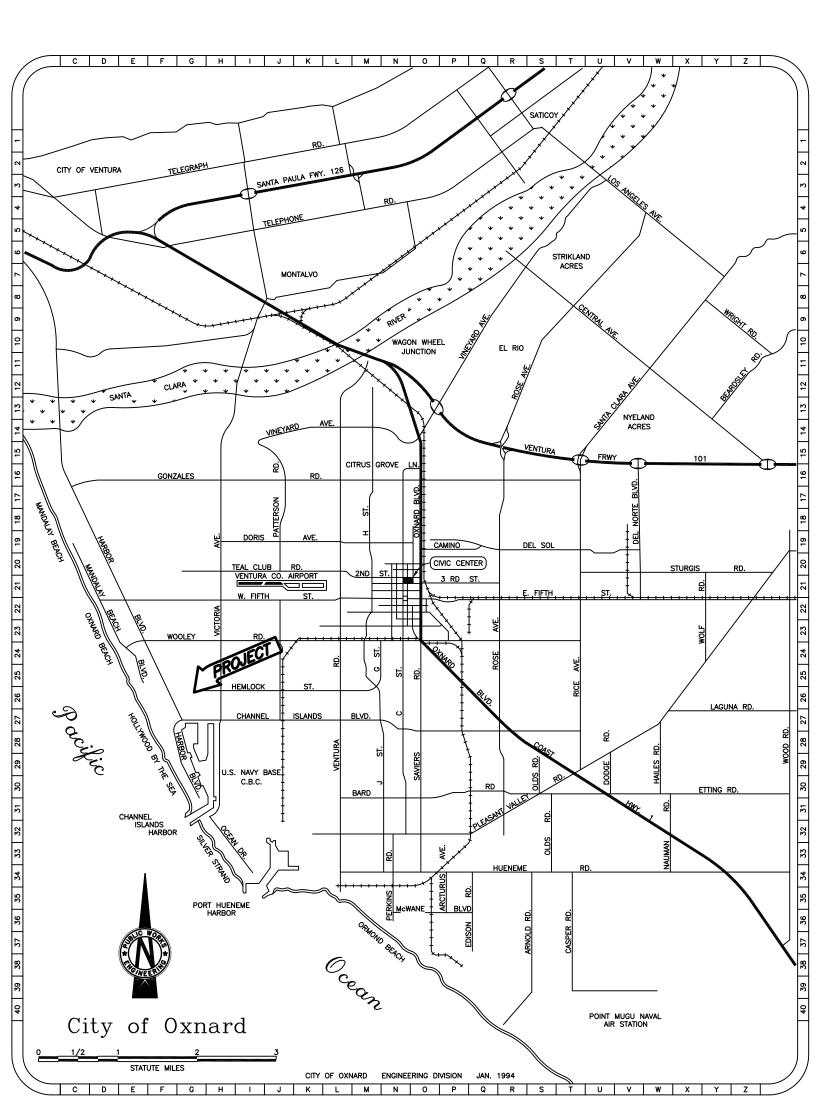


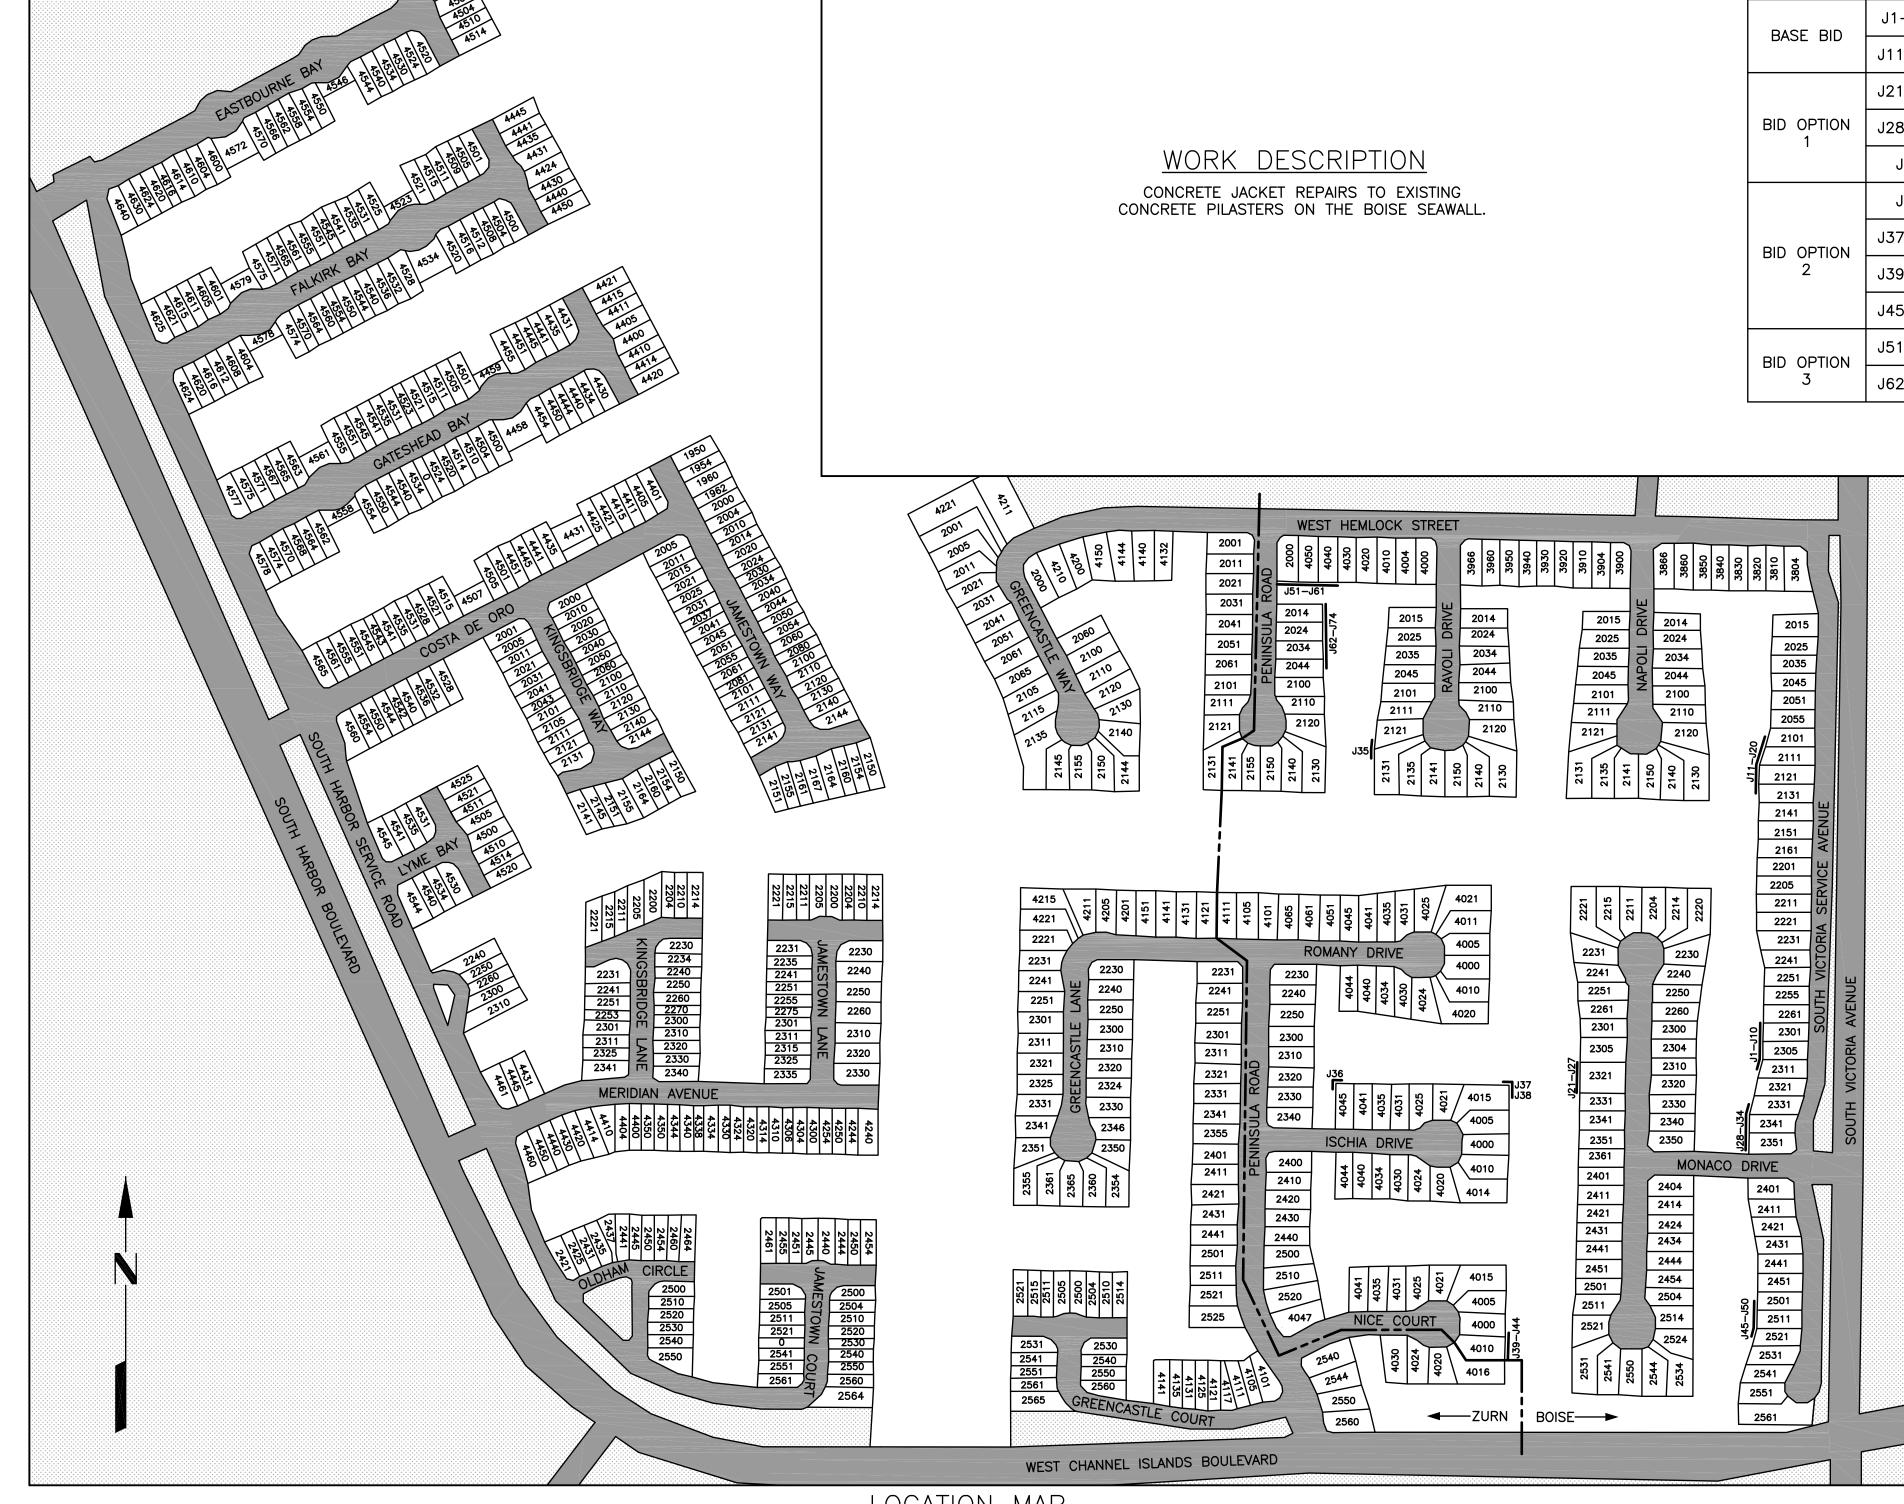

	WORK LOCATION						
BID OPTIONS	ITEMS	ADDRESS					
BASE BID	J1-J10	2301-2311 SOUTH VICTORIA AVENUE					
DASE DID	J11-J20	2101-2131 SOUTH VICTORIA AVENUE					
	J21-J27	2305-2331 MONACO DRIVE					
BID OPTION 1	J28-J34	2331-2351 SOUTH VICTORIA AVENUE					
·	J35	2121-2131 RAVOLI DRIVE					
	J36	4045 ISCHIA DRIVE					
BID OPTION	J37-J38	4015 ISCHIA DRIVE					
2	J39-J44	4000-4016 NICE COURT					
	J45-J50	2501-2521 SOUTH VICTORIA AVENUE					
BID OPTION	J51-J61	2000 PENINSULA ROAD - 4040 WEST HEMLOCK ROAD					
3	J62-J74	2014-2044 PENINSULA ROAD					

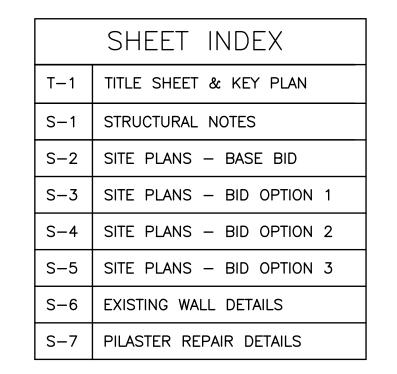



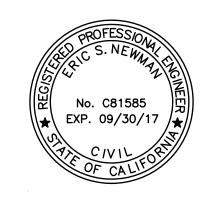



6 HUTTON CENTRE DRIVE SUITE 1250 SANTA ANA, CA 92707 PHONE: 714-708-6890

FAX: 714-242-9642

LOCATION MAP SCALE: 1" = 200'

UNDERGROUND SERVICE ALERT(USA) OF SOUTHERN CALIFORNIA

REVIEWED BY: DEVELOPMENT SERVICES TRAFFIC DIVISION

	I HEREBY
DIAL TOLL FREE 1-800-422-4133 AT LEAST TWO DAYS BEFORE YOU DIG	CONSTRU SAID PLA CHANGE DATE

RECORD DRAWING BY CERTIFY THAT THE WORK SHOWN ON DRAWING No. ____THROUGH_____,MARKED AS "RECORD DRAWING", HAS BEEN UCTED IN CONFORMANCE WITH LINES AND GRADES AS SHOWN ON ANS, DRAWINGS, REFERENCED SPECIFICATIONS, AND APPROVED ORDERS, AS INDICATED IN THE REVISION BLOCK.

OXNARD **PUBLIC WORKS** CAPITAL PROJECTS MANAGEMENT DIVISION TITLE SHEET & LOCATION MAP VERT.: AS SHOWN

REVISIONS

STRUCTURAL NOTES

A. GENERAL

- 1. NOTES AND DETAILS ON THE STRUCTURAL DRAWINGS TAKE PRECEDENCE OVER THESE GENERAL NOTES AND TYPICAL DETAILS. TYPICAL DETAILS SHALL BE USED WHENEVER
- 2. THE CONTRACTOR SHALL VERIFY ALL DIMENSIONS, ELEVATIONS, AND SITE CONDITIONS BEFORE STARTING WORK, AND SHALL RESOLVE CONFLICTS ON THE PLANS WITH THE ENGINEER BEFORE PROCEEDING WITH CONSTRUCTION. IN NO CASE SHALL DIMENSIONS BE SCALED FROM PLANS, SECTIONS, OR DETAILS ON THE STRUCTURAL DRAWINGS.
- 3. WHERE A CONSTRUCTION DETAIL IS NOT SHOWN OR NOTED, THE DETAIL SHALL BE THE SAME AS FOR OTHER SIMILAR WORK.
- 4. THE CONTRACTOR SHALL DETERMINE THE LOCATION OF UTILITY SERVICES IN THE AREA TO BE EXCAVATED, BEFORE BEGINNING EXCAVATION.
- 5. ALL MATERIALS AND WORKMANSHIP SHALL CONFORM TO THE REQUIREMENTS OF THE 2016 CBC. 6. THE CONTRACTOR SHALL ASSUME SOLE AND COMPLETE RESPONSIBILITY FOR ALL
- CONSTRUCTION MEANS, METHODS, TECHNIQUES, SEQUENCES, PROCEDURES, AND JOB 7. EACH SUBCONTRACTOR SHALL VERIFY ALL DIMENSIONS AND CONDITIONS RELATING TO
- HIS WORK BEFORE BEGINNING CONSTRUCTION. ANY DISCREPANCIES SHALL BE REPORTED TO THE CONTRACTOR IMMEDIATELY. FAILURE TO REPORT SUCH DISCREPANCIES INDICATES THE SUBCONTRACTOR'S ACCEPTANCE OF SUCH CONDITIONS.

B. REINFORCED CONCRETE

- 1. CONCRETE WORK SHALL CONFORM TO ALL REQUIREMENTS OF ACI 301, "SPECIFICATIONS FOR STRUCTURAL CONCRETE FOR BUILDINGS", EXCEPT AS MODIFIED BY THESE NOTES.
- . CEMENT SHALL CONFORM TO ASTM C150, TYPE II OR V.
- AGGREGATES FOR NORMAL WEIGHT CONCRETE SHALL CONFORM TO ASTM C33 AND SHALL NOT CONTAIN ANY SUBSTANCES WHICH MAY BE DELETERIOUSLY REACTIVE WITH ALKALIES IN THE CEMENT.
- 4. READY-MIX CONCRETE SHALL BE MIXED AND DELIVERED IN ACCORDANCE WITH ASTM
- 5. CONCRETE SHALL HAVE A MINIMUM COMPRESSIVE STRENGTH AT 28 DAYS AS FOLLOWS:
- PILASTER JACKETS: 5000 PSI 6. ADMIXTURES MAY BE USED WITH PRIOR APPROVAL OF THE ENGINEER. ADMIXTURES SHALL COMPLY WITH ASTM C494 & C1017 AND BE OF A TYPE THAT INCREASES THE WORKABILITY OF THE CONCRETE, BUT SHALL NOT BE CONSIDERED TO REDUCE THE SPECIFIED MINIMUM CEMENT CONTENT (CALCIUM CHLORIDE SHALL NOT BE USED).
- 7. WATER/CEMENT RATIO SHALL NOT EXCEED 0.40.
- 8. POZZOLAN CONFORMING TO ASTM C618 TYPE F SHALL COMPRISE 15 TO 20 PERCENT ON ALL CEMENTITIOUS MATERIALS.
- 9. MAXIMUM SLUMP SHALL BE 4" BEFORE THE ADDITION OF ADMIXTURES.
- 10. ENGINEER SHALL REVIEW AND APPROVE MIX DESIGNS BEFORE INSTALLATION. 11. BAR REINFORCEMENT SHALL BE ASTM A615, GRADE 60, EPOXY COATED CONFORMING TO ASTM A775, INCLUDING DOWELS. ALL TIE WIRE SHALL BE PLASTIC COATED, NO EXCEPTIONS. ALL CUTTING & FIELD BENDING OF BARS WHICH CRACKS OR DAMAGES
- EPOXY COATING SHALL BE PATCHED WITH APPROVED COATING MATERIAL. 12. MINIMUM LAP SPLICES OF REINFORCING BARS SHALL BE PER THE LAP CLASS B REBAR SPLICE SCHEDULE BELOW. STAGGER SPLICE LOCATION 2'-0" MINIMUM. DO NOT SPLICE VERTICAL BARS.
- 13. REINFORCING DETAILING, BENDING, AND PLACING SHALL BE IN ACCORDANCE WITH THE CONCRETE REINFORCING STEEL INSTITUTE "MANUAL OF STANDARD PRACTICE", LATEST
- EDITION. 14. REINFORCING STEEL SHALL BE PROVIDED WITH THE FOLLOWING AMOUNTS OF COVER FOR CAST-IN-PLACE CONCRETE:
- CONCRETE SURFACE (FORMED) EXPOSED TO SEAWATER: 3" CONCRETE PLACED AGAINST EXISTING CONCRETE: 2"
- 15. ALL REINFORCING STEEL, ANCHOR BOLTS, DOWELS, AND INSERTS SHALL BE WELL SECURED IN POSITION WITH WIRE POSITIONERS BEFORE PLACING CONCRETE OR
- 16. PROJECTING CORNERS OF PILASTERS SHALL BE FORMED WITH A 3/4" MIN. CHAMFER. 17. ENGINEER SHALL REVIEW AND APPROVE REBAR SHOP DRAWINGS BEFORE FABRICATION. 18. ALL NEW CONCRETE PLACED AGAINST HARDENED CONCRETE SHALL BE PREPARED
- PER THE FOLLOWING PROCEDURE: A) CLEAN OFF ALL MARINE GROWTH.
- B) ROUGHEN HARDENED SURFACE TO AN AMPLITUDE OF 1/4" WITH BUSH HAMMER OR HIGH PRESSURE WATER BLAST WAND.
- C) CLEAN SURFACES OF DUST AND DEBRIS USING HIGH PRESSURE WATER BLAST WAND.
- D) THE EXISTING CONCRETE SURFACE SHALL BE WETTED WITH FRESH WATER WITHIN 15 MINUTES OF PLACING FRESH CONCRETE.

EPOXY COATED REINF LAP SPLICE						
BAR SIZE	LAP CLASS A	LAP CLASS B				
#3	19"	25"				
#4	26"	33"				
# 5	32"	42"				
#6	39"	50"				
#7	56"	73"				
#8	64"	83"				
•	•	•				

GRADE 60 BARS, 5,000 PSI CONC.

C. DESIGN CRITERIA

- 1. DESIGN CODES:
- a. 2016 CALIFORNIA BUILDING CODE (CBC)

D. SPECIAL INSPECTION

1. SPECIAL INSPECTION IS REQUIRED PER CHAPTER 17 OF THE 2016 CBC FOR CONCRETE WORK, EPOXY WORK & REBAR WELDING (IF NEEDED). REFER TO THE MATERIAL SPECIFIC TABLES FOR ACTIVITY INSPECTION AND FREQUENCY.

E. STRUCTURAL OBSERVATIONS


CONTACT ENGINEER A MINIMUM OF 24 HOURS IN ADVANCE.

- 1. AFTER FIRST ROUND OF PILASTER DEMOLITION IS COMPLETE,
- PRIOR TO PLACING REBAR.
- 2. PRIOR TO FIRST ROUND OF CONCRETE PLACEMENT, AFTER REBAR IS IN PLACE & BEFORE FORMS ARE CLOSED.

ABBREVIATIONS


@ AWG BUILDING BLK BLK'G BM BOT. BRG. C/C C.I.P. C.J.	AT AMERICAN WIRE GUAGE BUILDING BLOCK BLOCKING BEAM BOTTOM BEARING CENTER TO CENTER CAST—IN—PLACE CONSTRUCTION JOINT	MIN. MID. MTL (N) NO. NOM. N.T.S. O.C. O.D. OPN'G OPP.	MINIMUM MIDDLE METAL NEW NUMBER NOMINAL NOT TO SCALE ON CENTER OUTSIDE DIAMETER OPPOSITE
€ CL., CLR	CENTERLINE CLEAR	OPT. P.E.	OPTIONAL POLYETHYLENE
CMU	CONCRETE MASONRY UNIT	P	PLATE
CONC.	CONCRETE CONNECTION	PLY.	PLYWOOD
CONN.	CONNECTION	PSF	POUNDS PER SQUARE FOOT
CONST. CONT.	CONSTRUCTION CONTINUOUS	PCF PMPCM	POUNDS PER CUBIC FOOT POLYMER MODIFIED PORTLAN
DIA., Ø	DIAMETER	I WII CIVI	CEMENT MORTAR
DIM.	DIMENSION	PSI	POUNDS PER SQUARE INCH
(E)	EXISTING	P.T.	PRESSURE TREATED
EA.	EACH FACE	PVC REINF.	POLY VINYL CHLORIDE REINFORCEMENT
E.A. EL, ELEV.	EACH FACE ELEVATION		REQUIRED
	EMBEDMENT	S	SEWER
EQ.	EQUAL	SCHED.	SCHEDULE
	EACH SIDE	SHT	SHEET
E.W.	EACH WAY		SLAB-ON-GRADE
EXP. FTG	EXPANSION FOOTING	S.S. STD	STAINLESS STEEL STANDARD
GA.	CACE /CALICE	STI	STEFI
GR. BM	GRADE BEAM	STRUCT. SQ.	STRUCTURAL
GALV.	GALVANIZED	SQ.	SQUARE
G.S.M.	GALVANIZED SHEET METAL	I LIVIT.	TEMPENATONE
G.W.	GANGWAY	T.O.S. TYP.	TOP OF SLAB TYPICAL
H, HORIZ. HDR	HORIZONTAL HEADER	U.N.O.	UNLESS NOTED OTHERWISE
H.D.G.	HOT DIPPED GALVANIZED	V, VERT.	VERTICAL
H.D.P.E.	HIGH DENSITY POLYETHYLENE	W	WIDTH
HT	HEIGHT	W/	WITH
I.D. KSI	INSIDE DIAMETER	WWF W D	WELDED WIRE FABRIC
MAX.	KIPS PER SQUARE INCH MAXIMUM	W.P. W.P.J.	WORKING POINT WEAKENED PLANE JOINT
1717 37 34		7711 101	


	TABLE 1704.4 REQUIRED VERIFICATION	AND INSPECTI	ON OF COI	NCRETE CONSTR	UCTION
\	VERIFICATION AND INSPECTION TASK	CONTINUOUS	PERIODIC	REFERENCED STANDARD	IBC REFERENCE
1.	INSPECTION OF REINFORCING STEEL AND PLACEMENT.		X	ACI 318: 3.5, 7.1-7.7	1913.4
2.	INSPECTION OF INSTALLATION OF EPOXY DOWELS INSTALLED IN HARDENED CONCRETE.	X		ACI 318: 3.8.6, 8.1.3, 21.2.8	1912.1
3.	VERIFYING USE OF REQUIRED DESIGN MIX.		X	ACI 318: Ch.4, 5.2-5.4	1904.2.2 1913.2, 1913.3
4.	AT THE TIME FRESH CONCRETE IS SAMPLED TO FABRICATE SPECIMENS FOR STRENGTH TESTS, PERFORM SLUMP TESTS, AND DETERMINE THE TEMPERATURE OF THE CONCRETE.	×		ASTM C 172 ASTM C 31 ACI 318: 5.6, 5.8	1913.10
5.	INSPECTION OF CONCRETE PLACEMENT FOR PROPER APPLICATION TECHNIQUES.	X		ACI 318: 5.9, 5.10	1913.6, 1913.7, 1913.8
6.	INSPECT FORMWORK FOR SHAPE, LOCATION AND DIMENSIONS OF THE CONCRETE MEMBER BEING FORMED.		×	ACI 318: 6.1.1	
7.	INSPECTION OF FIELD WELDING OF SUPPLEMENTAL REINFORCING	×		AWS D1.4	

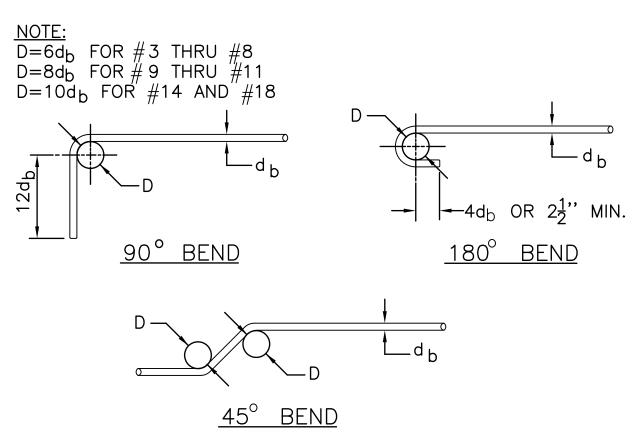


TYP. REINFORCEMENT BENDS SCALE: NO SCALE




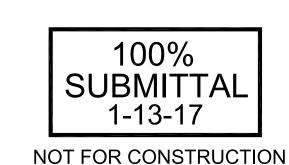


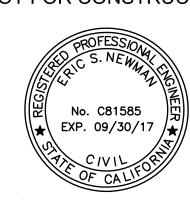



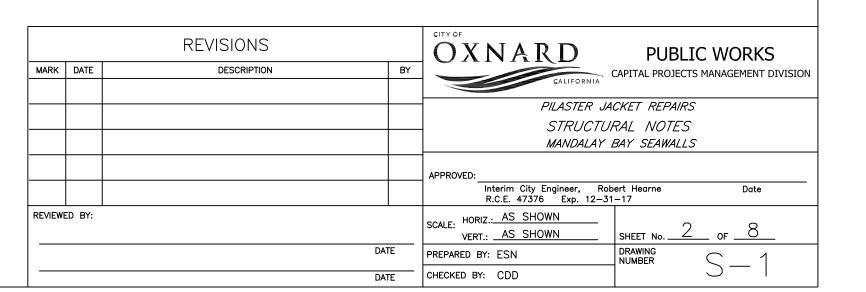


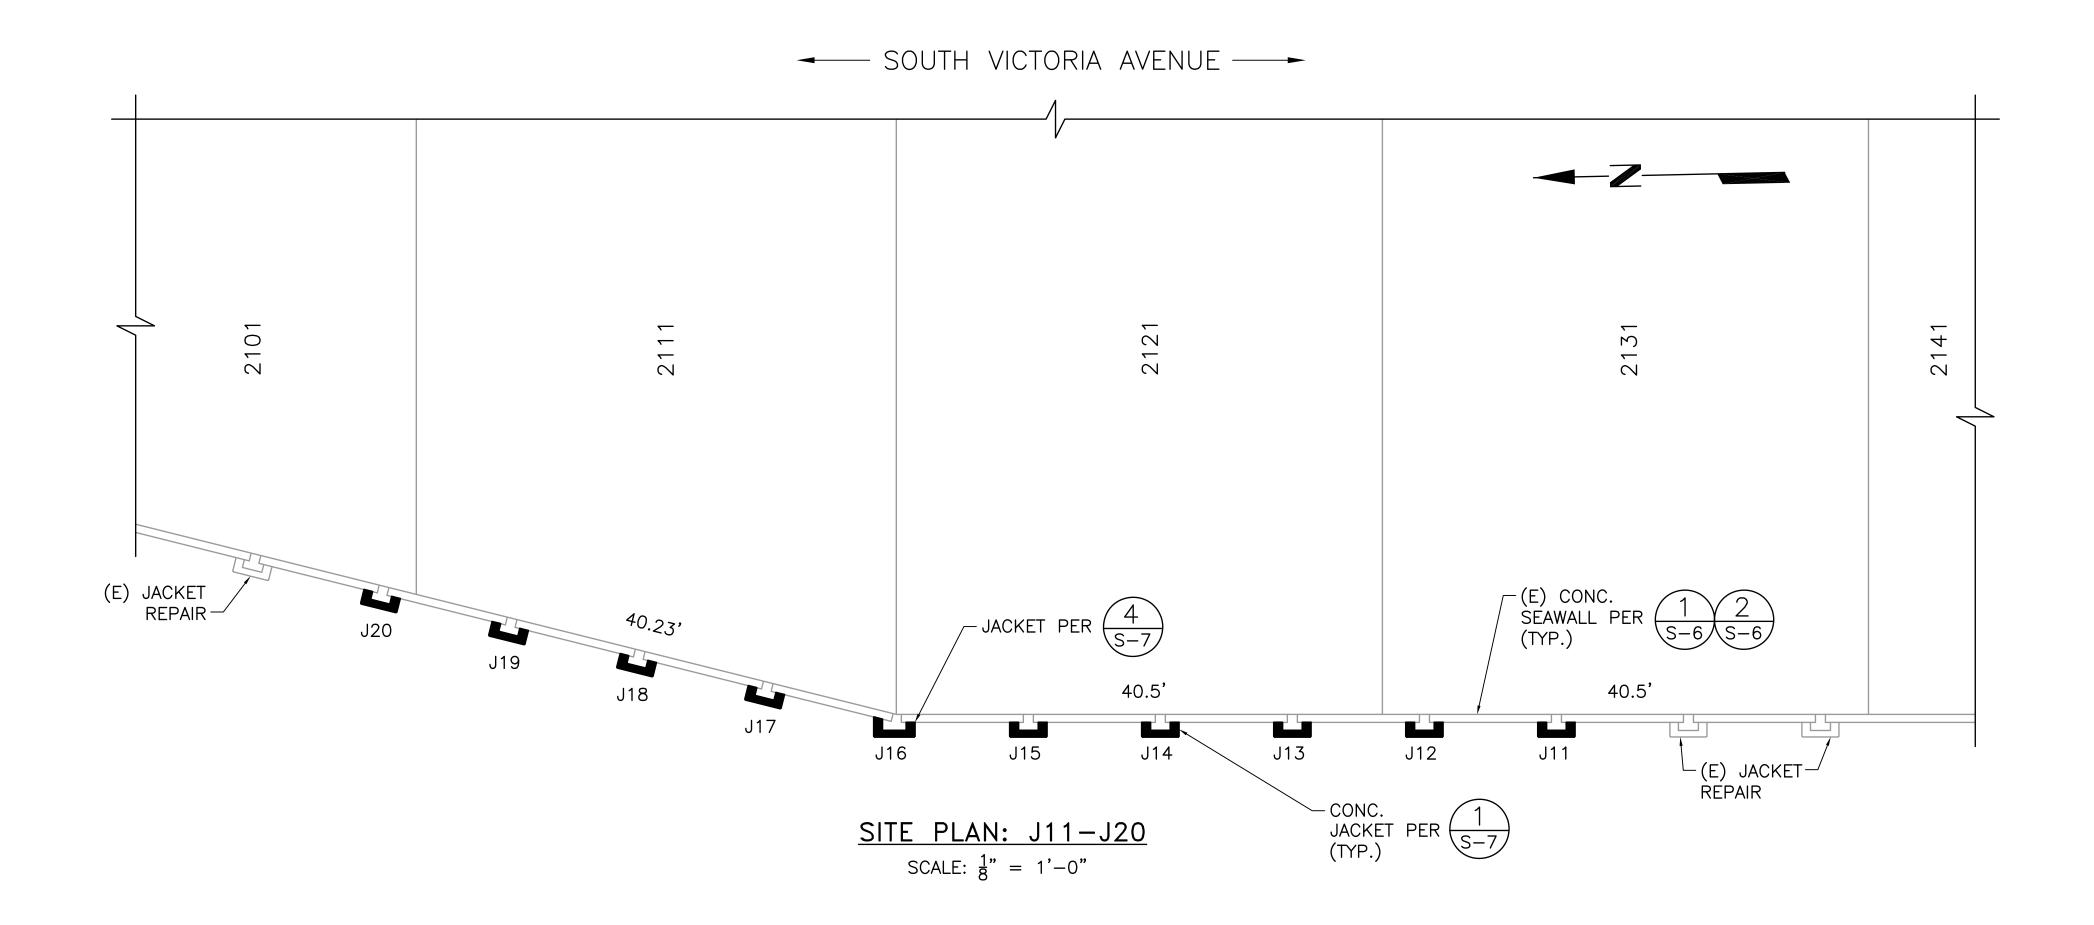

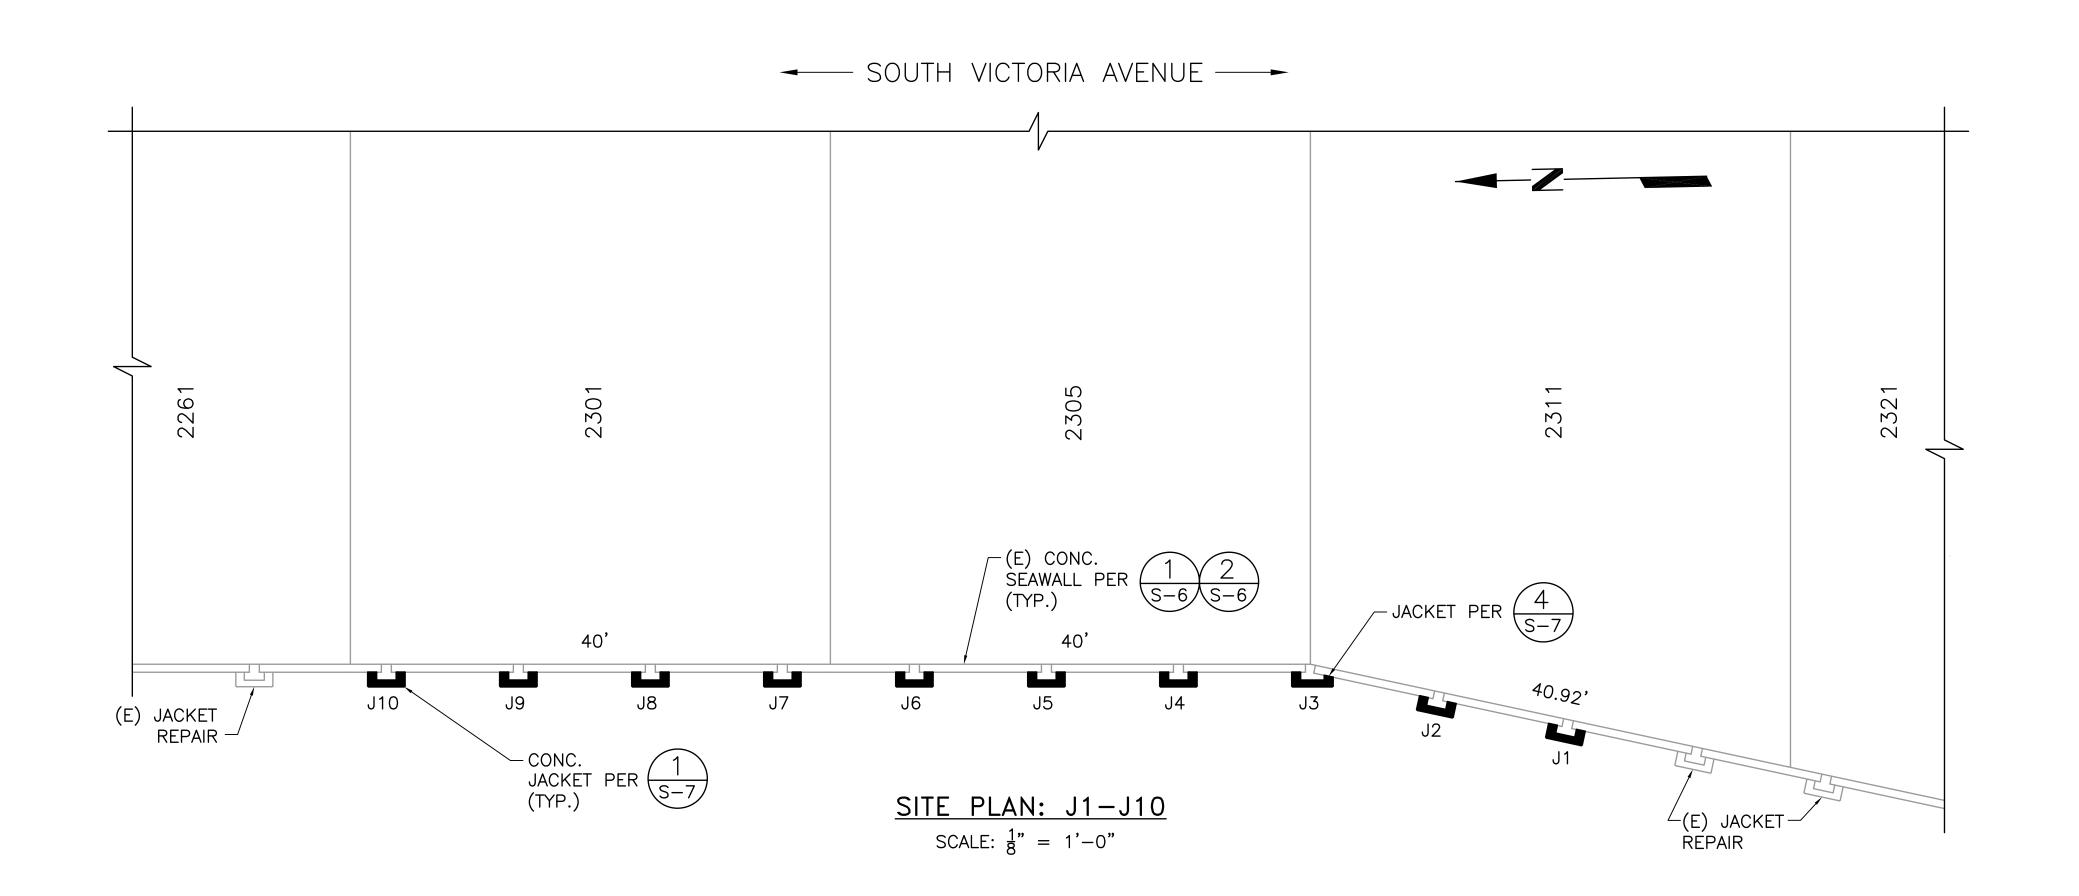

- SHEET NOTES:

 1. CONTRACTOR TO FIELD VERIFY EXISTING DIMENSIONS OF PILASTERS PRIOR TO FABRICATING REBAR OR FORMS.
- 2. CONTRACTOR TO VISIT THE SITE OF EACH REPAIR PRIOR TO SUBMITTING BID TO DETERMINE IF ANY EXISTING DECKS, DOCKS, GANGWAYS, PLATFORMS OR GUIDE PILES INTERFERE WITH HIS WORK APPROACH OR MEANS & METHODS. CONTRACTOR TO INCLUDE THE COST OF MOVING INTERFERING ITEMS IN HIS BID. TEMPORARY STORAGE LOCATION WILL BE PROVIDED IN THE WATERWAYS NEAR EACH SITE WITHIN THE MANDALAY COMMUNITY. OWNERS WILL HANDLE BOAT MOVES PROVIDED A 30 DAY NOTICE / REQUEST IS PROVIDED BY THE CONTRACTOR.

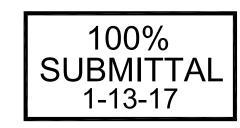










		REVISIONS		OXNARD PUBLIC WORKS
MARK	DATE	DESCRIPTION	BY	CAPITAL PROJECTS MANAGEMENT DIVISION
				PILASTER JACKET REPAIRS
				SITE PLAN — BASE BID
				MANDALAY BAY SEAWALLS
				APPROVED:
				Interim City Engineer, Robert Hearne Date R.C.E. 47376 Exp. 12-31-17
REVIEWE	ED BY:			SCALE: HORIZ.: AS SHOWN VERT.: AS SHOWN SHEET No. 3 OF 8
			DATE	PREPARED BY: ESN DRAWING NUMBER
			DATE	CHECKED BY: CDD

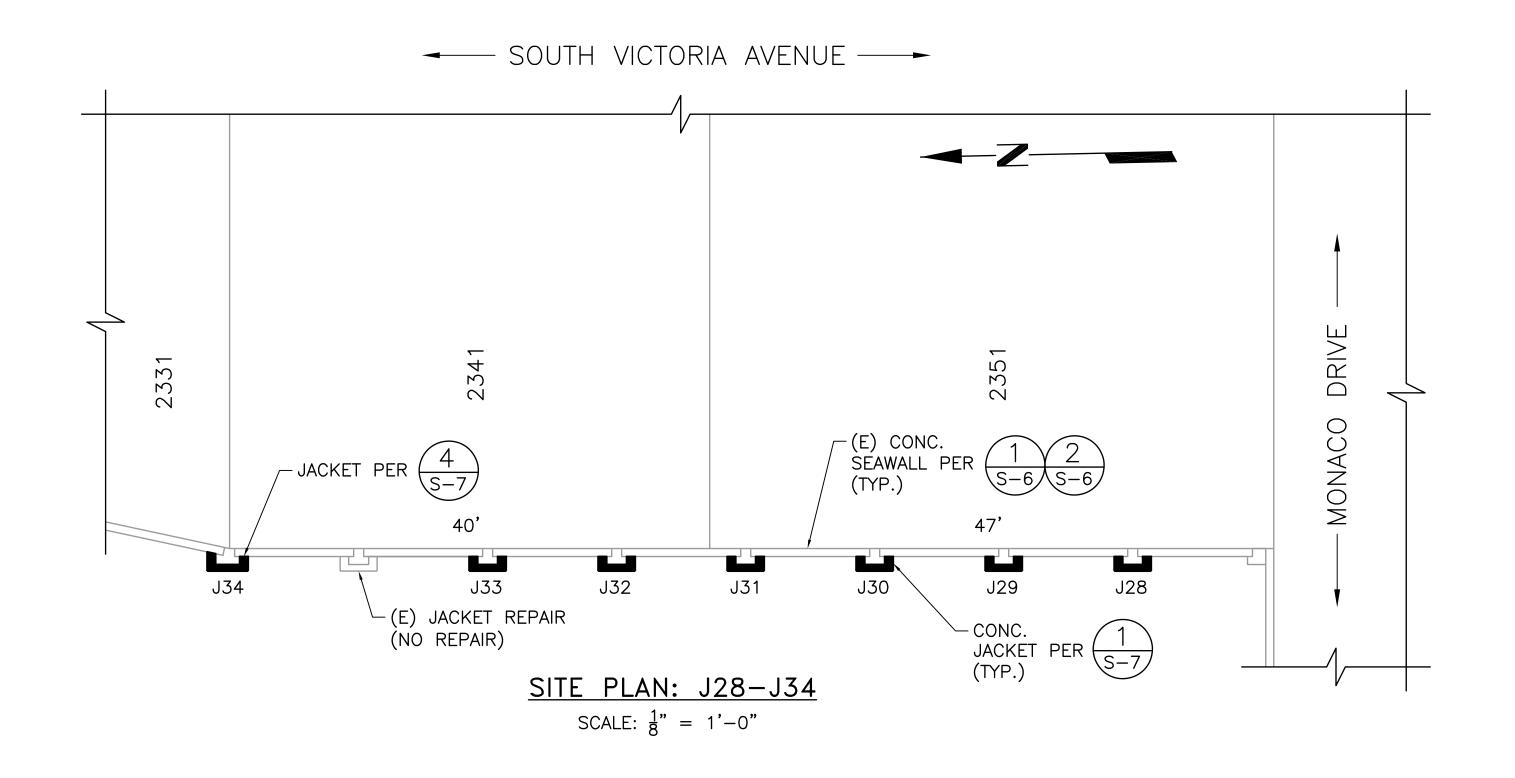

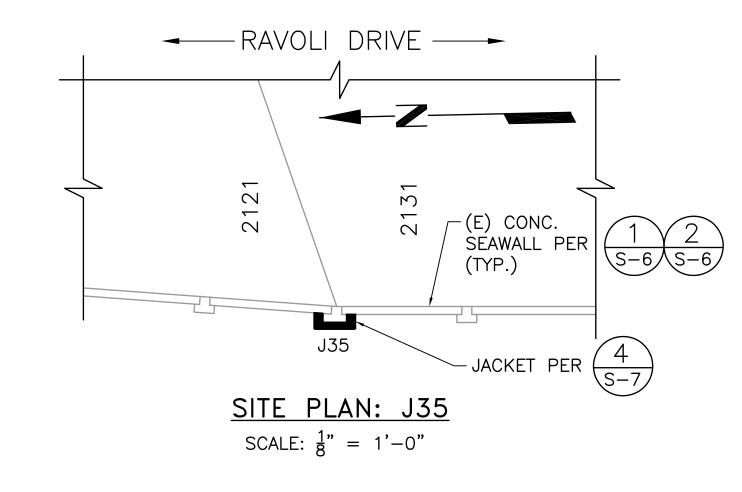

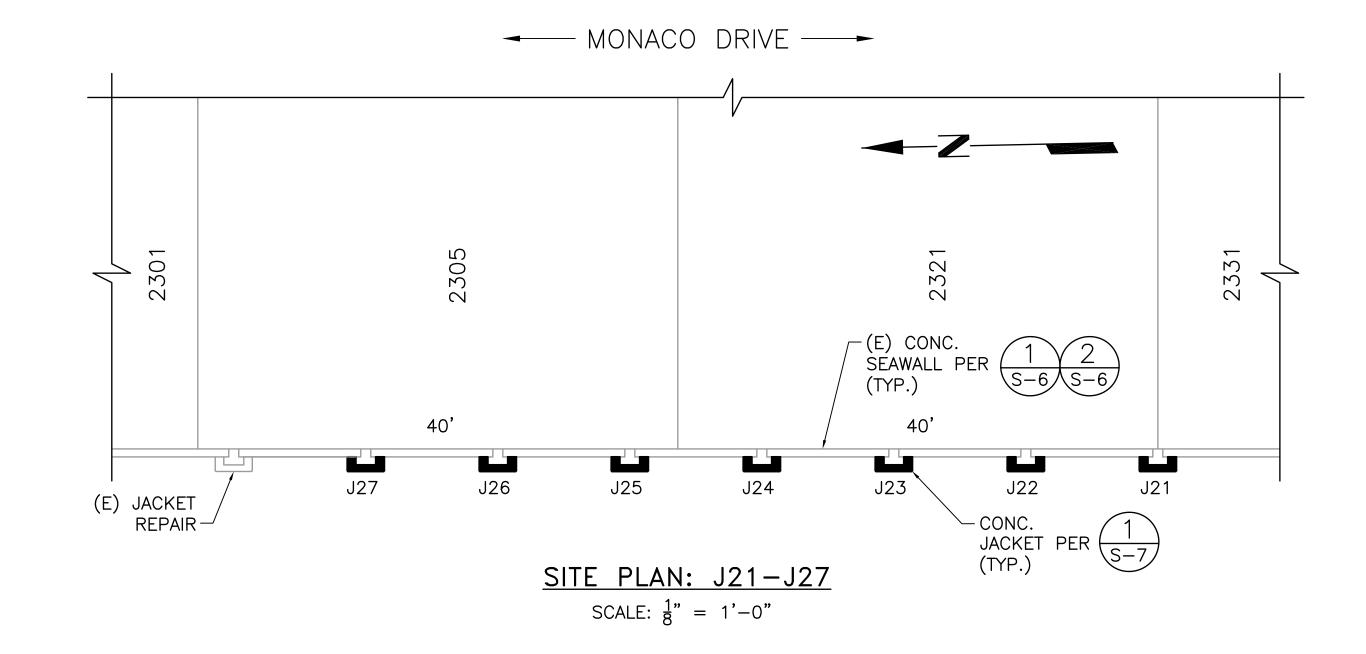




- SHEET NOTES:

 1. CONTRACTOR TO FIELD VERIFY EXISTING DIMENSIONS OF PILASTERS PRIOR TO FABRICATING
- REBAR OR FORMS.

 2. CONTRACTOR TO VISIT THE SITE OF EACH REPAIR PRIOR TO SUBMITTING BID TO DETERMINE IF ANY EXISTING DECKS, DOCKS, GANGWAYS, PLATFORMS OR GUIDE PILES INTERFERE WITH HIS WORK APPROACH OR MEANS & METHODS.
 CONTRACTOR TO INCLUDE THE
 COST OF MOVING INTERFERING ITEMS IN HIS BID. TEMPORARY
 STORAGE LOCATION WILL BE
 PROVIDED IN THE WATERWAYS
 NEAR EACH SITE WITHIN THE MANDALAY COMMUNITY. OWNERS WILL HANDLE BOAT MOVES PROVIDED A 30 DAY NOTICE / REQUEST IS PROVIDED BY THE CONTRACTOR.

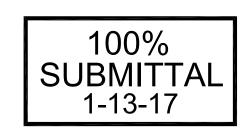











		REVISIONS		OXNARD PUBLIC WORKS
MARK	DATE	DESCRIPTION	BY	CAPITAL PROJECTS MANAGEMENT DIVISION
				PILASTER JACKET REPAIRS
				SITE PLAN — BID OPTION 1
				MANDALAY BAY SEAWALLS
				APPROVED:
				Interim City Engineer, Robert Hearne Date R.C.E. 47376 Exp. 12—31—17
REVIEW	ED BY:			SCALE: HORIZ.: AS SHOWN SHEET No. 4 OF 8
			DATE	PREPARED BY: ESN DRAWING NUMBER
			DATE	CHECKED BY: CDD

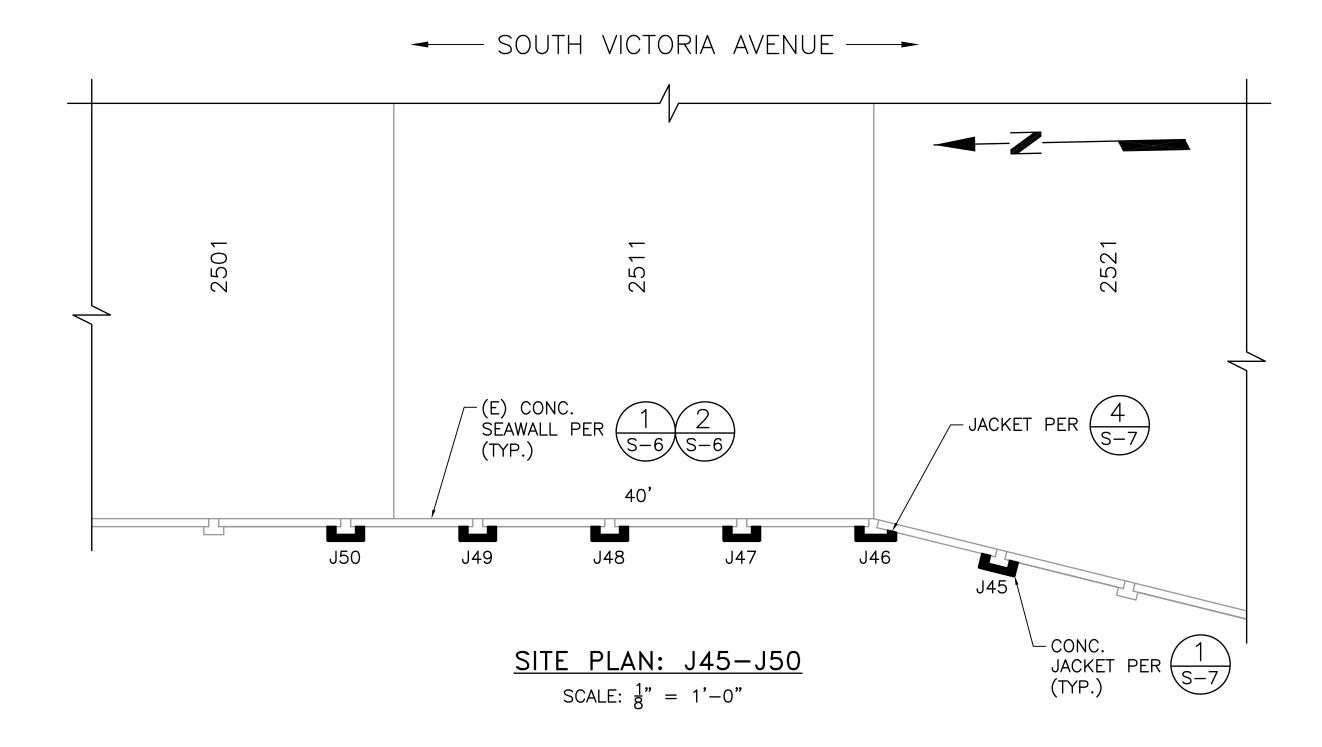

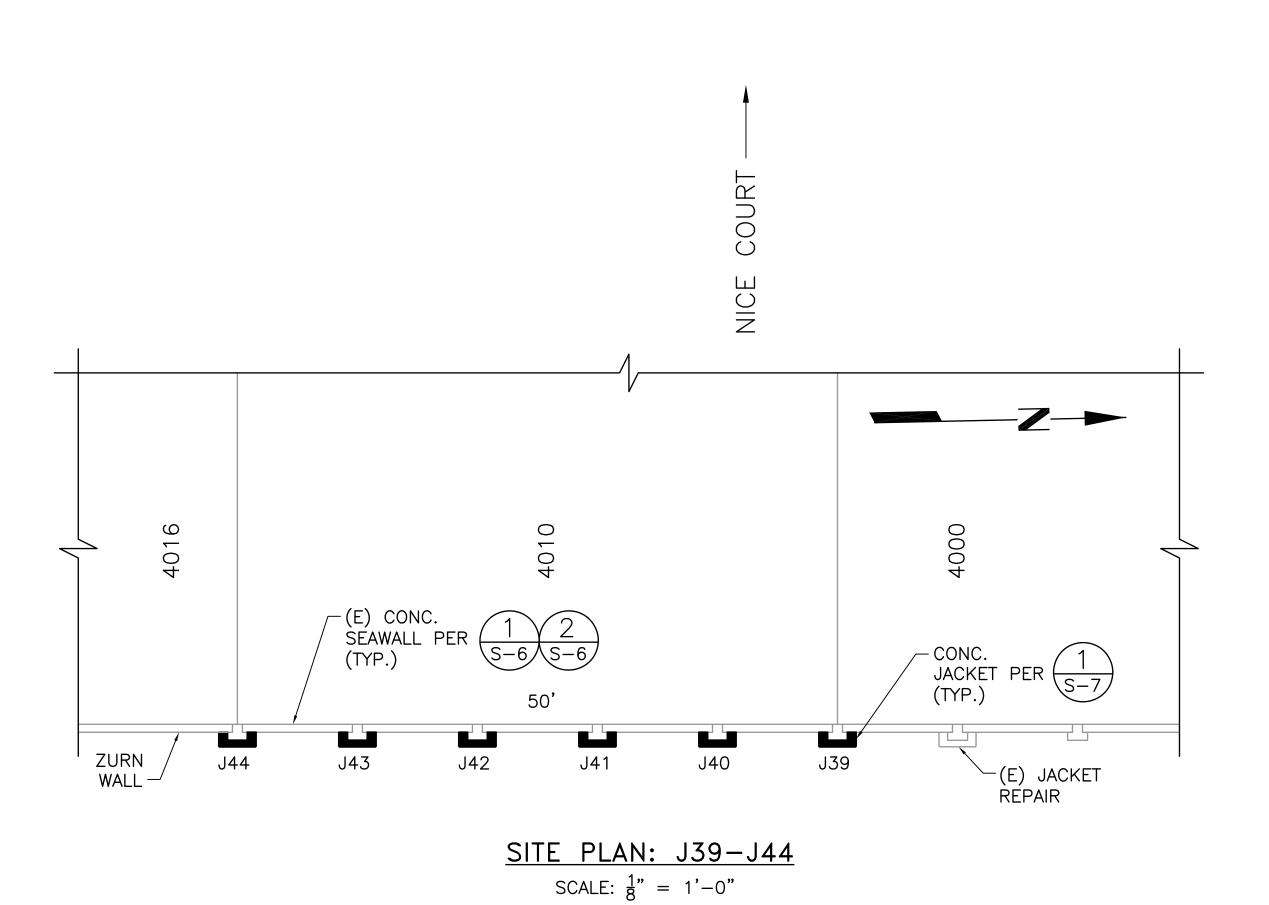

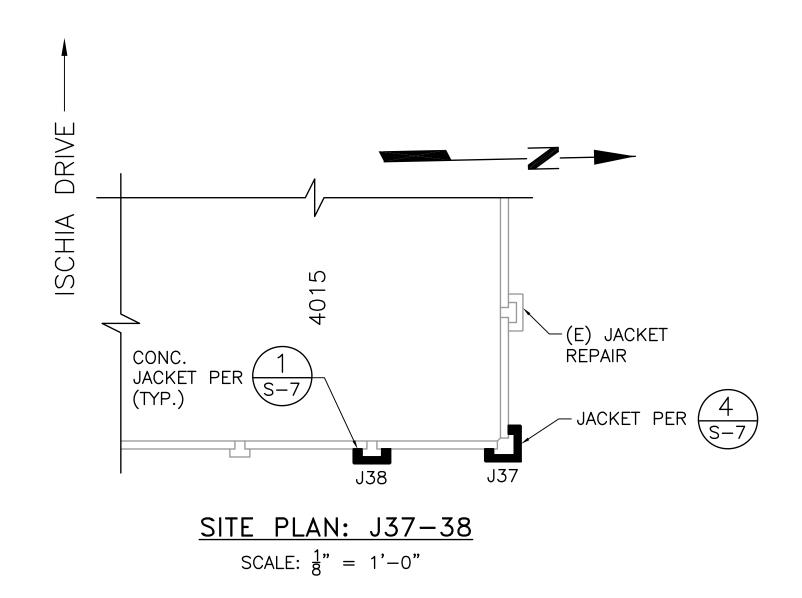


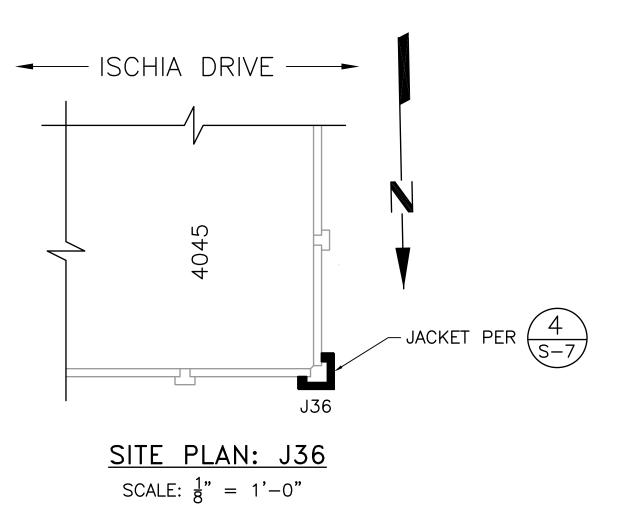



- SHEET NOTES:


 1. CONTRACTOR TO FIELD VERIFY EXISTING DIMENSIONS OF PILASTERS PRIOR TO FABRICATING REBAR OR FORMS.
- 2. CONTRACTOR TO VISIT THE SITE OF EACH REPAIR PRIOR TO SUBMITTING BID TO DETERMINE IF ANY EXISTING DECKS, DOCKS, GANGWAYS, PLATFORMS OR GUIDE PILES INTERFERE WITH HIS WORK APPROACH OR MEANS & METHODS. CONTRACTOR TO INCLUDE THE COST OF MOVING INTERFERING ITEMS IN HIS BID. TEMPORARY STORAGE LOCATION WILL BE PROVIDED IN THE WATERWAYS NEAR EACH SITE WITHIN THE MANDALAY COMMUNITY. OWNERS WILL HANDLE BOAT MOVES PROVIDED A 30 DAY NOTICE / REQUEST IS PROVIDED BY THE CONTRACTOR.

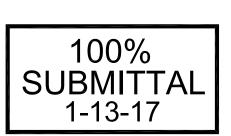


NOT FOR CONSTRUCTION





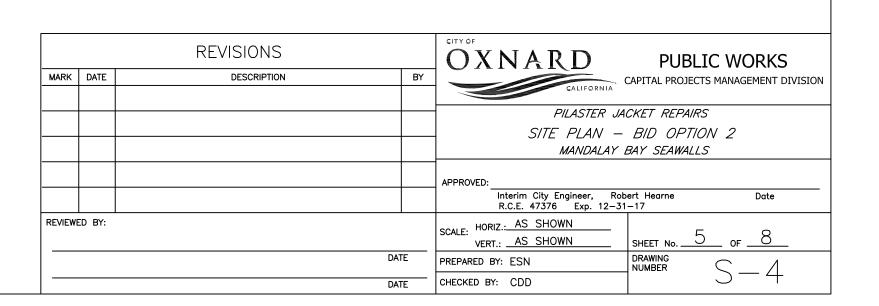


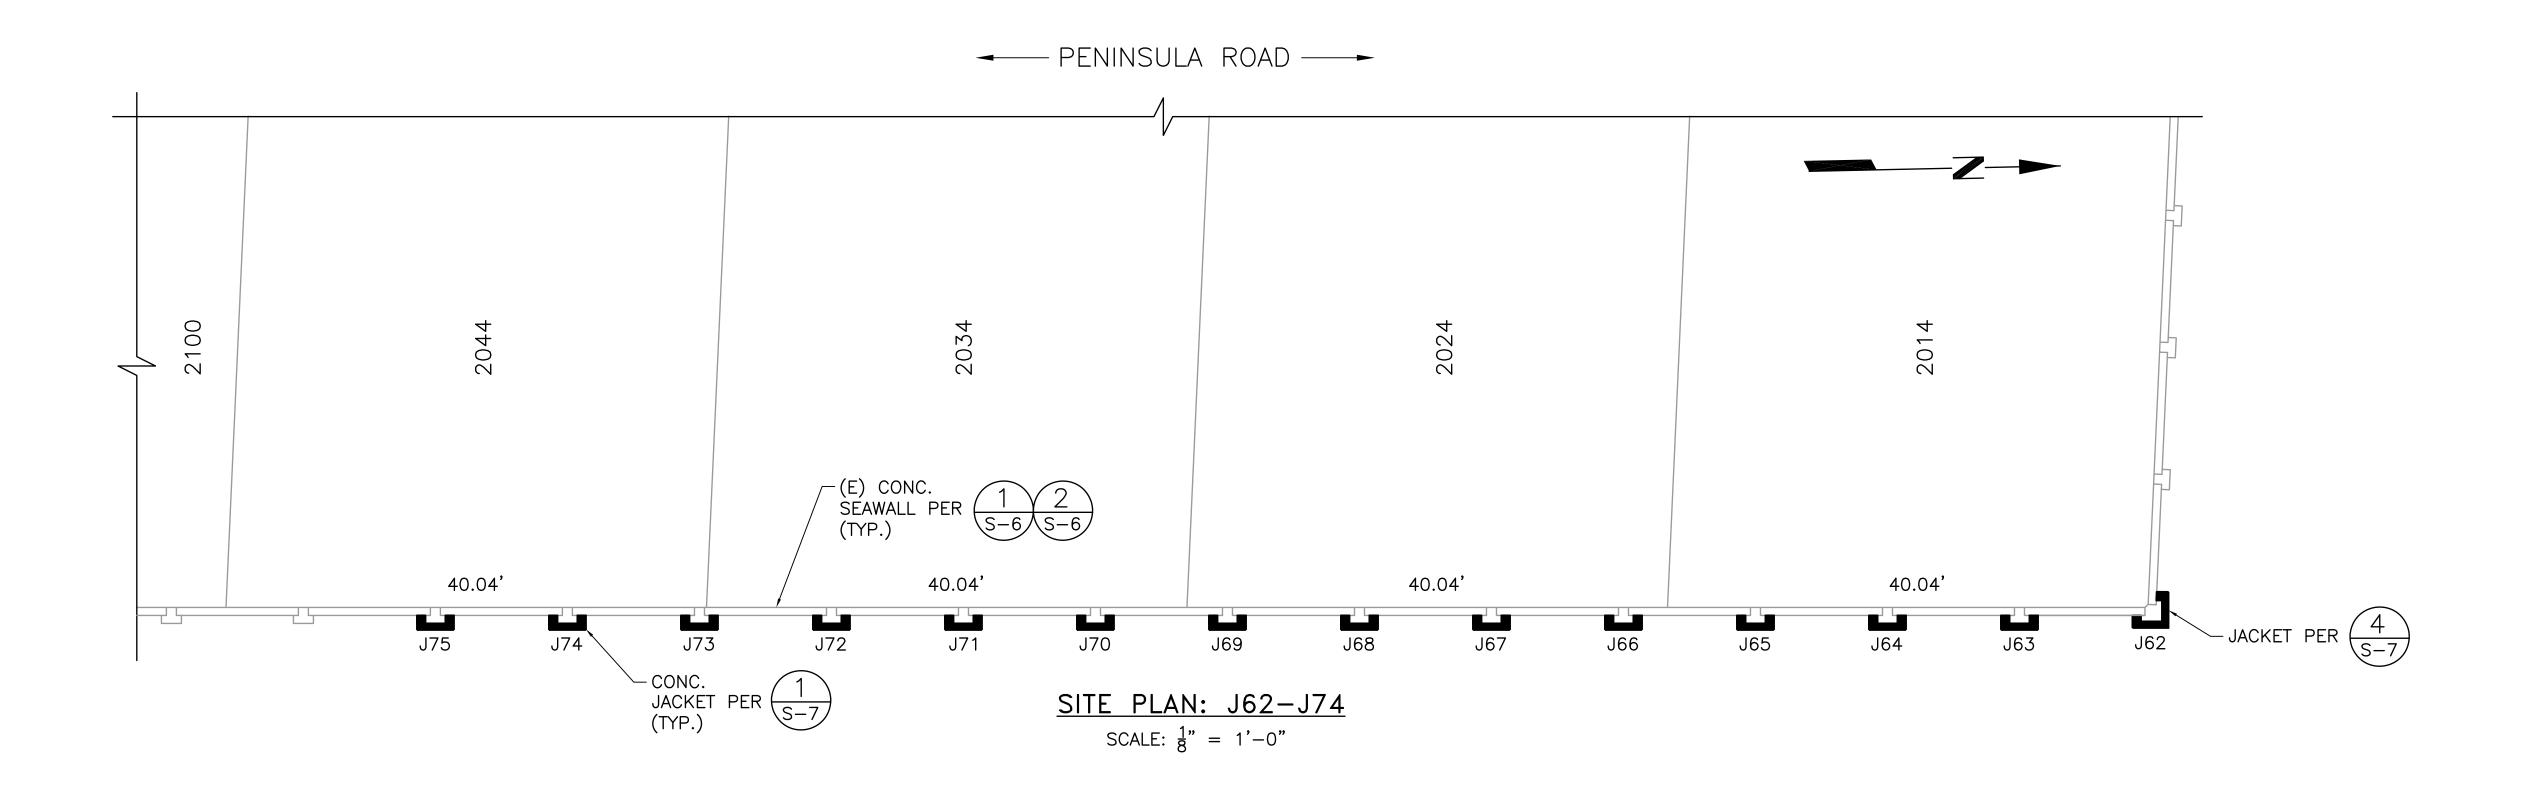


SHEET NOTES:

1. CONTRACTOR TO FIELD VERIFY EXISTING DIMENSIONS OF PILASTERS PRIOR TO FABRICATING REBAR OR FORMS.

2. CONTRACTOR TO VISIT THE SITE OF EACH REPAIR PRIOR TO SUBMITTING BID TO DETERMINE IF ANY EXISTING DECKS, DOCKS, GANGWAYS, PLATFORMS OR GUIDE PILES INTERFERE WITH HIS WORK APPROACH OR MEANS & METHODS. CONTRACTOR TO INCLUDE THE COST OF MOVING INTERFERING ITEMS IN HIS BID. TEMPORARY STORAGE LOCATION WILL BE PROVIDED IN THE WATERWAYS NEAR EACH SITE WITHIN THE MANDALAY COMMUNITY. OWNERS WILL HANDLE BOAT MOVES PROVIDED A 30 DAY NOTICE / REQUEST IS PROVIDED BY THE CONTRACTOR.

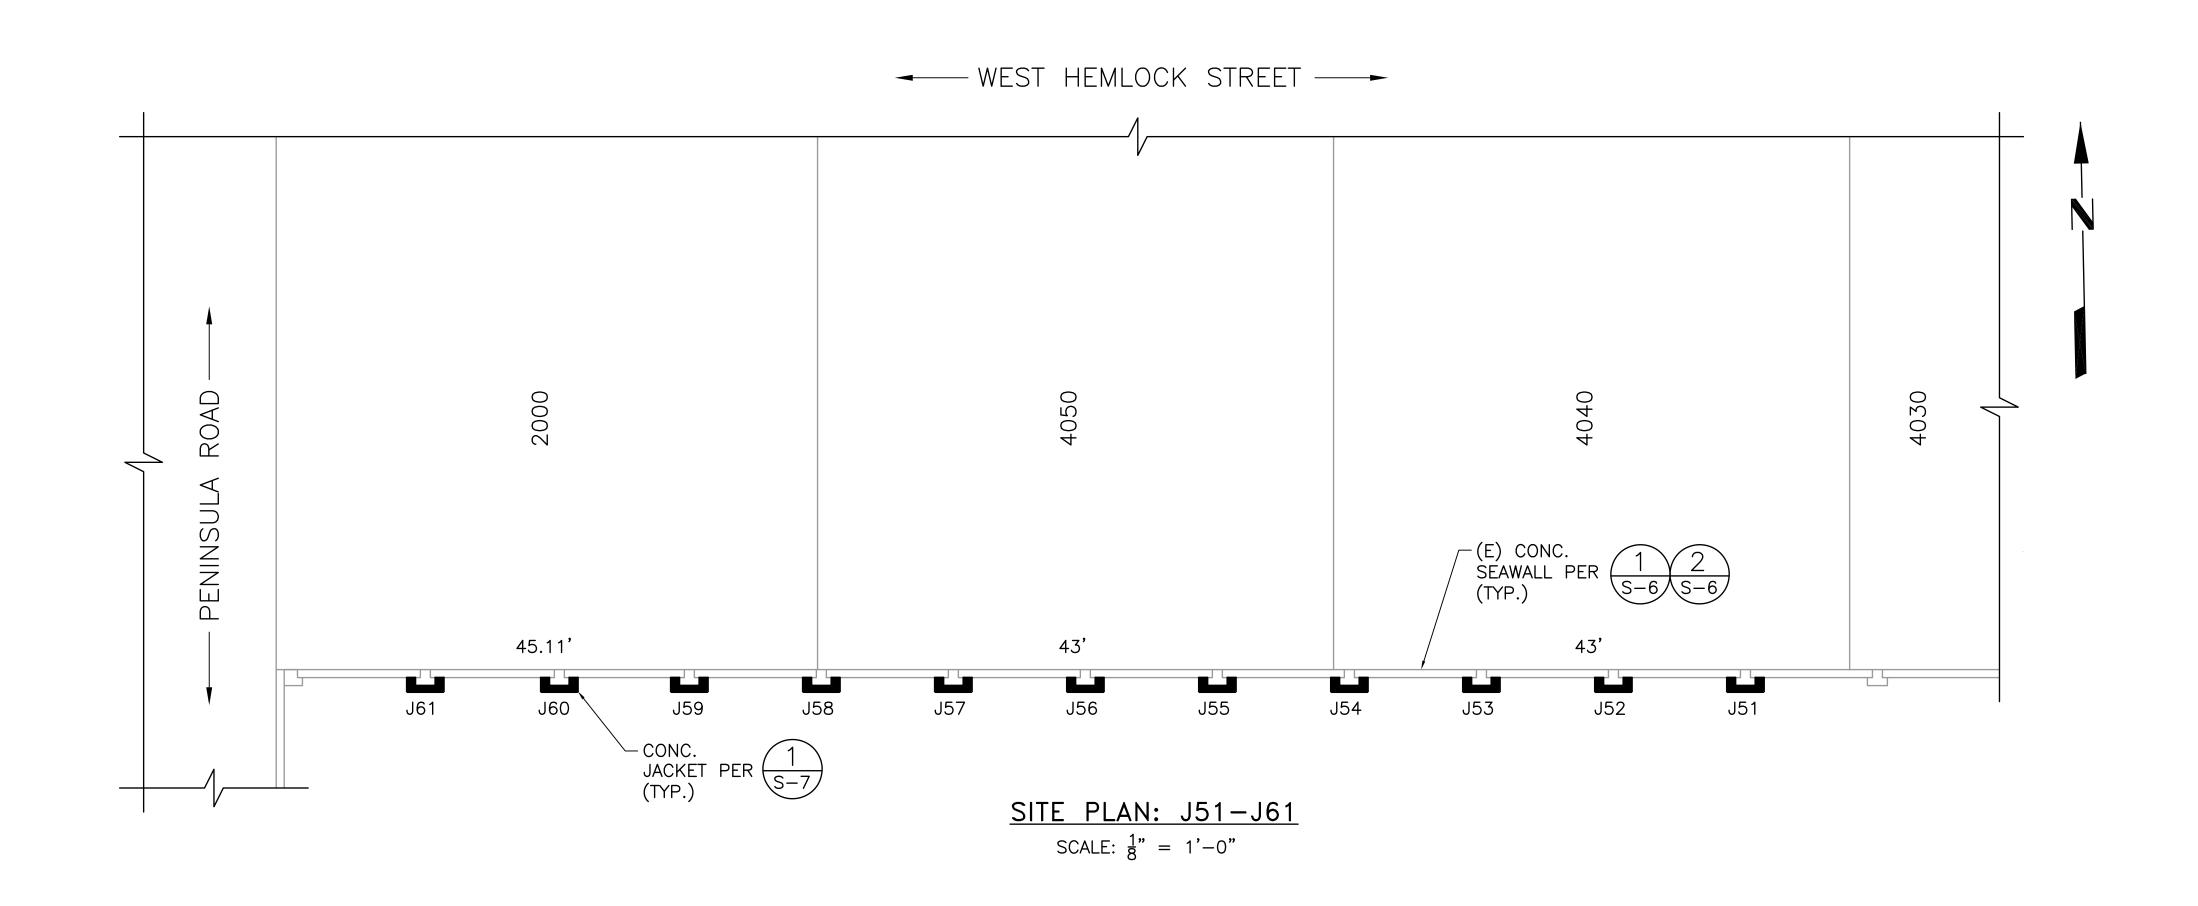

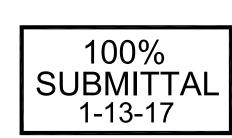










		REVISIONS		OXNARD PUBLIC WORKS
MARK	DATE	DESCRIPTION	BY	CAPITAL PROJECTS MANAGEMENT DIVISION
				PILASTER JACKET REPAIRS
				SITE PLAN — BID OPTION 3
				MANDALAY BAY SEAWALLS
				APPROVED:
				Interim City Engineer, Robert Hearne Date R.C.E. 47376 Exp. 12—31—17
REVIEW	ED BY:			SCALE: HORIZ.: AS SHOWN SHEET No. 6 OF 8
			DATE	PREPARED BY: ESN DRAWING NUMBER
			DATE	CHECKED BY: CDD

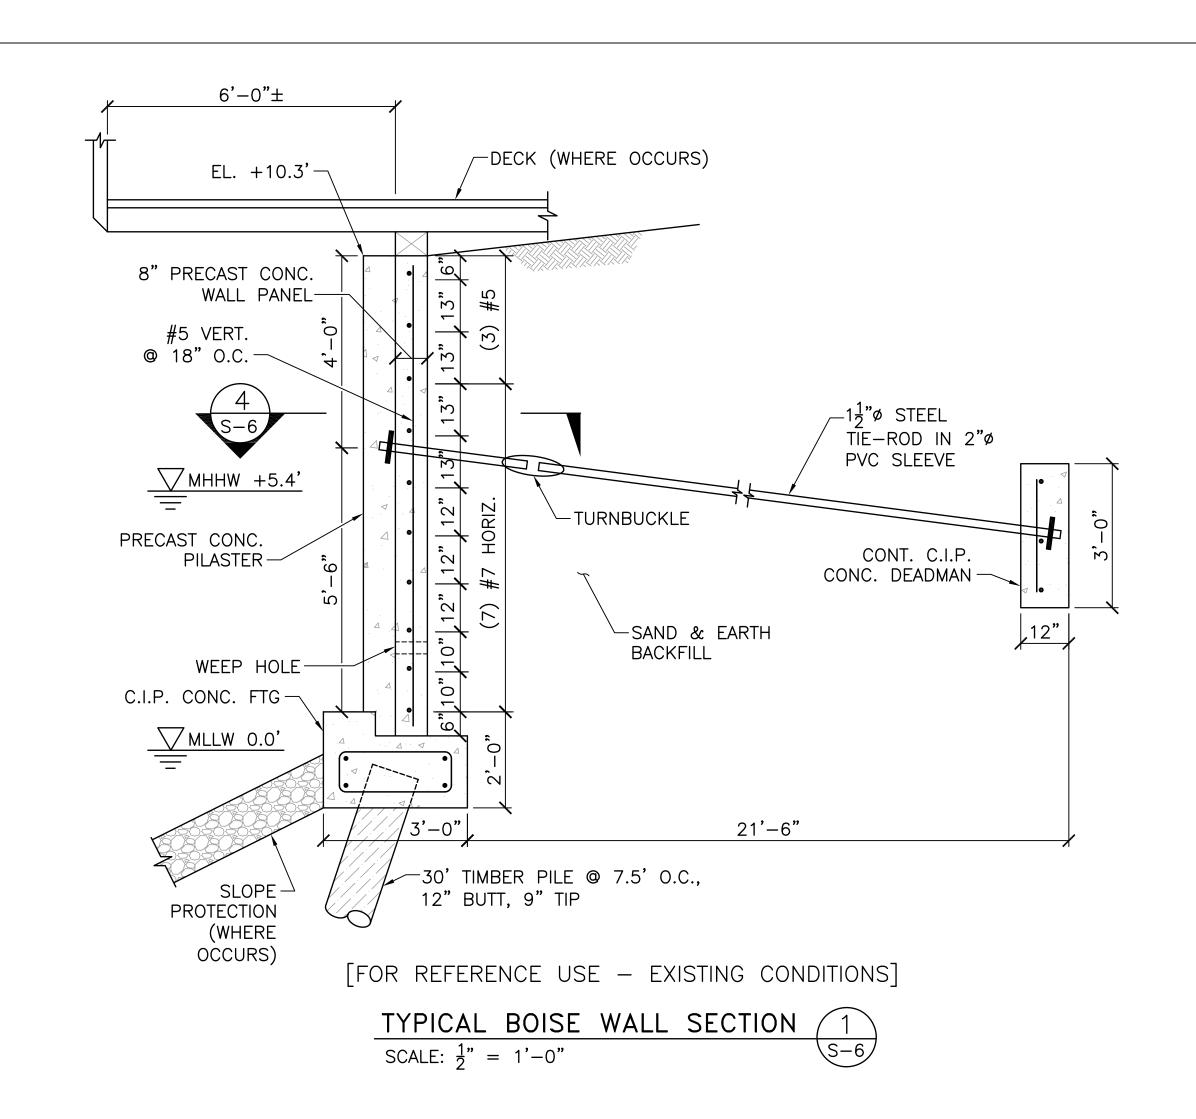

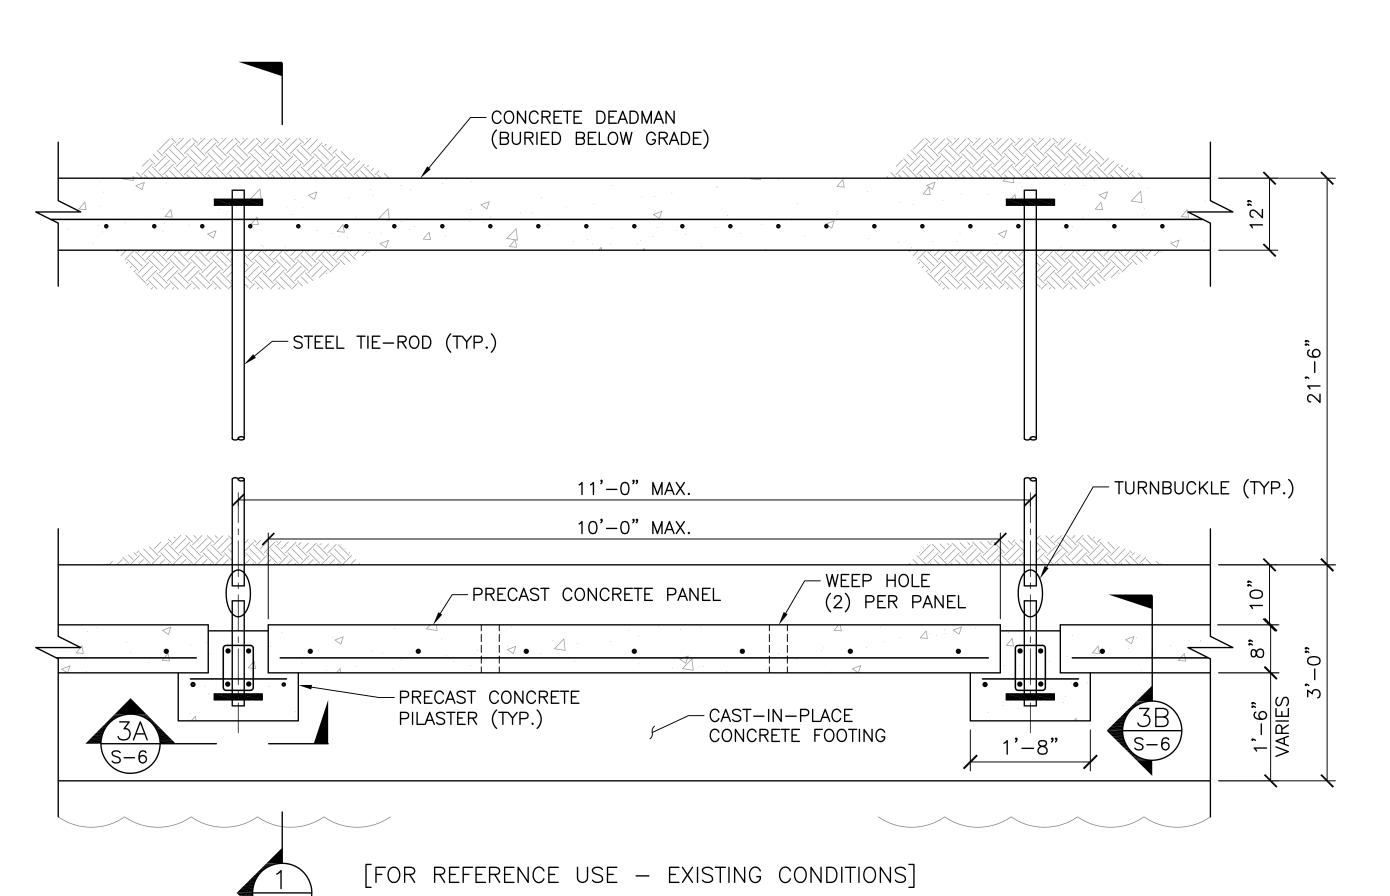

TYPICAL BOISE WALL PLAN (2)

SCALE: $\frac{3}{4}$ " = 1'-0"

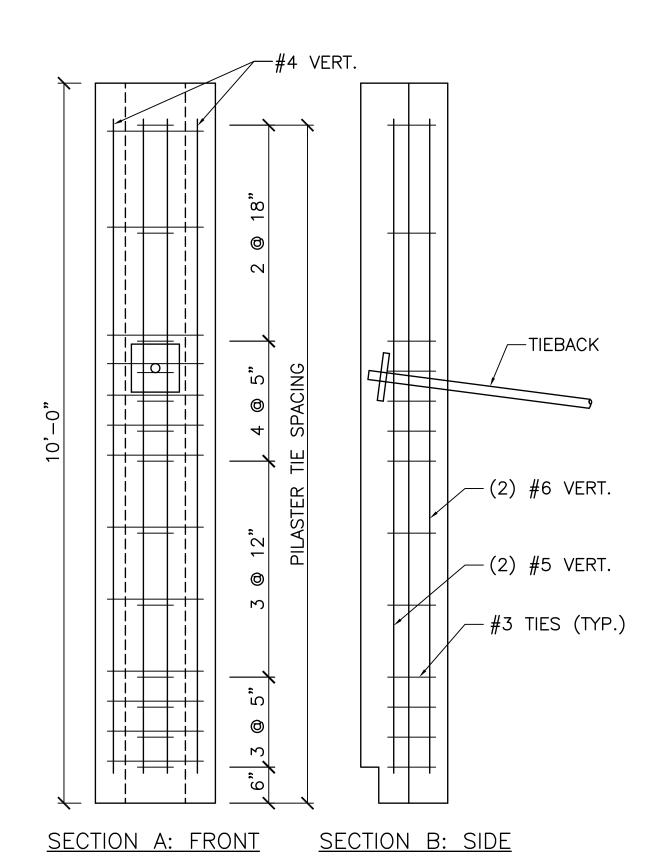


[FOR REFERENCE USE - EXISTING CONDITIONS]

TYPICAL BOISE PILASTER SECTIONS 3SCALE: $\frac{3}{4}$ " = 1'-0"

DEMOLITION NOTES:


- 1. REMOVE & DISPOSE ONLY LOOSE AND CRACKED CONCRETE.
- USE HANDHELD CHIPPING TOOLS 25# OR LESS TO AVOID DAMAGING CONCRETE TO REMAIN.
- 3. DEMO LIMIT SHOWN ON DETAILS IS THE MAXIMUM DEMOLITION
- DEPTH. ACTUAL DEPTH IS LESS WHEN CONCRETE IS SOUND.
 4. DO NOT DEMOLISH BEYOND DEMO LIMIT WITHOUT PRIOR
- ENGINEER APPROVAL.
- MECHANICALLY CLEAN ALL EXPOSED REBAR TO REMOVE ALL LOOSE RUST.
- 6. IF ANY GAP IS EXPOSED BEHIND AN EXISTING BAR, REMOVE
- 3" OF CONCRETE AROUND THE BAR TO ALLOW NEW CONCRETE COMPACTION.
- 7. REPLACE ALL BARS WITH GREATER THAN 50% CORROSION LOSS WITH NEW UNCOATED REINFORCING.
- 8. APPLY CORROSION INHIBITOR SIKA ARMATEC 110 EPOCEM OR ENGINEER APPROVED EQUAL TO ALL EXPOSED STEEL PER

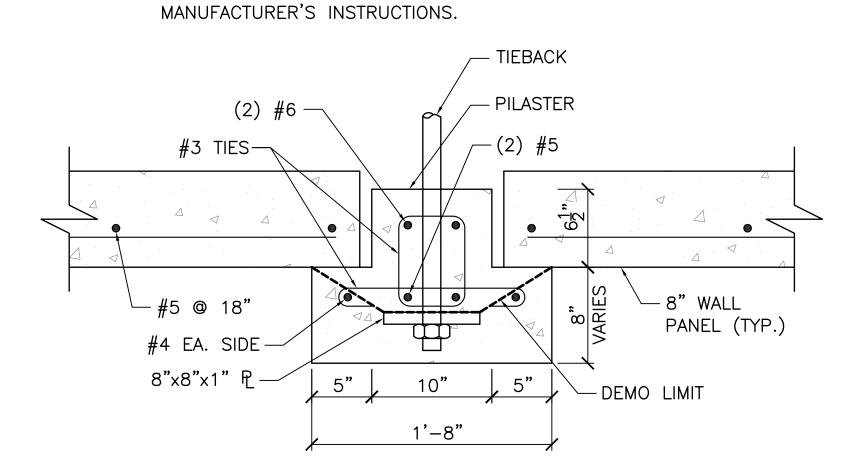



[FOR REFERENCE USE - EXISTING CONDITIONS]

TYPICAL PILASTER SECTION 4SCALE: $1\frac{1}{2}$ " = 1'-0"

S-6

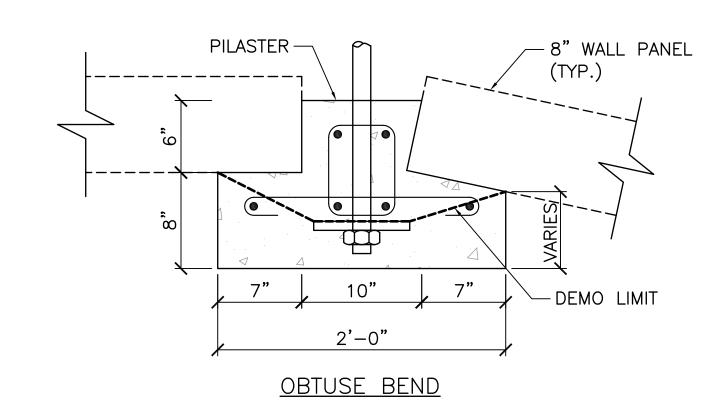

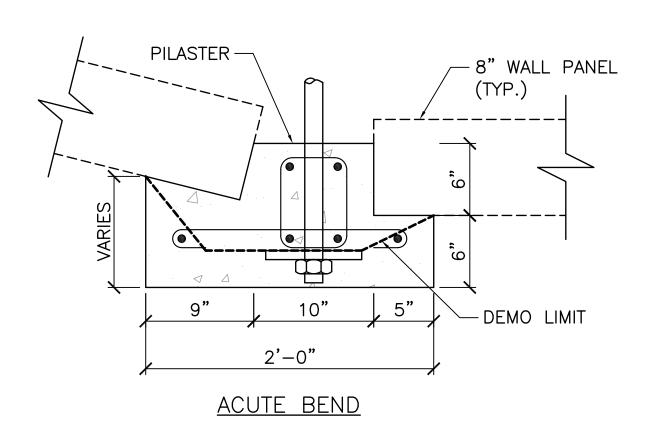

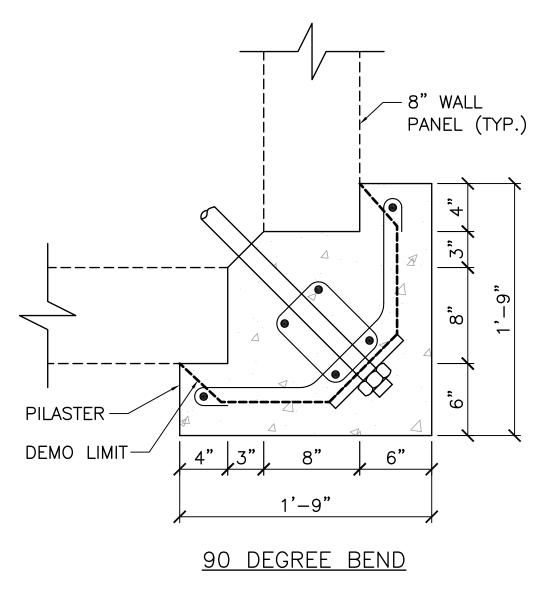

100% SUBMITTAL 1-13-17

[FOR REFERENCE USE - EXISTING CONDITIONS]

CORNER PILASTER DETAILS 5SCALE: $1\frac{1}{2}$ " = 1'-0"





		REVISIONS		CITY OF
MARK	DATE	DESCRIPTION	BY	OXNARD PUBLIC WORKS CAPITAL PROJECTS MANAGEMENT DIVISION
				PILASTER JACKET REPAIRS
				EXISTING WALL DETAILS MANDALAY BAY SEAWALLS
				APPROVED:
				Interim City Engineer, Robert Hearne Date R.C.E. 47376 Exp. 12—31—17
REVIEW	ED BY:			SCALE: HORIZ.: AS SHOWN VERT.: AS SHOWN SHEET No. 7 OF 8
		DATE DATE		PREPARED BY: ESN CHECKED BY: CDD DRAWING NUMBER S — 6

